CITY OF ST. PAUL, AL CIASSIT SOLID WASTI FACILITY ST. PAUL ISLAND, ALASKA

SCOPE OF WORK:

THE PROJECT WILL PROVIDE THE ISLAND OF SAINT PAUL WITH A FINAL DISPOSAL SITE FOR THE COMMUNITY'S MUNICIPAL AND HARBOR SOLID WASTE WITH A TRANSFER FACILITY AT THE EXISTING ATAQAN LANDFILL AND A NEW SOLID WASTE DISPOSAL SITE AT THE AALAX SUBDIVISION WITH FEATURES AS NOTED BELOW:

ATAQAN SUBDIVISION - TRANSFER FACILITY - NO WORK SCOPE AT ATAQUN SITE ON MARCH 2023 PLAN SET

AALAX SUBDIVISION - POLOVINA LANDFILL


- 1. CONSTRUCT REMAINDER OF ACCESS ROAD TO SITE (SEE SHEETS R-2, R-10)
- 2. CONSTRUCT CLASS III SOLID WASTE DISPOSAL FACILITY AS SHOWN THESE PLANS AND PER ADEC PERMIT.
- 3. INSTALL A PERIMETER FENCE AND SIGNAGE. 4. CONSTRUCT EQUIPMENT STORAGE BUILDING, BY OTHERS.
- 5. CONSTRUCT BURN BOX AND ASSOCIATED SITE IMPROVEMENTS, BY OTHERS.

OPERATION PLAN IS COVERED IN THE COMMUNITY SOLID WASTE MANAGEMENT PLAN AND LANDFILL OPERATIONS GUIDE.

LANDFILL CLOSURE PLAN:

WHEN SOLID WASTE PLACEMENT IN THE "WORKING CELL" IS FILLED TO 2 FEET BELOW THE FINAL CLOSURE ELEVATION SHOWN IN THE PLANS, THE NEXT CELL SHALL BE OPENED AND THE "WORKING CELL" SHALL BE CLOSED BY PLACEMENT OF FINAL COVER, GRADING, PLACING TOPSOIL AND REVEGETATING IN ACCORDANCE WITH THESE PLANS. THAT PORTION OF THE LANDFILL SHALL BE CONSIDERED "CLOSED" AND OFF LIMITS TO FUTURE OPERATIONS. SEE ORIGINAL 2003 PLANSET FOR FUTURE CELL DETAILS.

- 1. UPON CLOSURE OF THE LANDFILL FACILITY, THE CITY SHALL CONDUCT ANNUAL INSPECTIONS FOR 5 YEARS, AS SPECIFIED IN SECTION 18 AAC 60.800 ADEC SOLID WASTE MANAGEMENT REGULATIONS DATED SEPTEMBER 7, 2002.
- 2. PRIOR TO THE END OF THE 5 YEAR POST-CLOSURE MONITORING PERIOD THE CITY SHALL HAVE A NOTATION ON THE DEED TO THE PROPERTY RECORDED NOTIFYING POTENTIAL PURCHASERS OR LEASEHOLDERS THAT THE PROPERTY WAS USED AS A CLASS III
- MUNICIPAL SOLID WASTE LANDFILL, AS SPECIFIED IN 18 AAC 60.369. (9/7/02 VERSION) 3. AT THE END OF THE 5 YEAR POST CLOSURE MONITORING PERIOD THE CITY SHALL SUBMIT A REPORT TO ADEC IN ACCORDANCE WITH 18 AAC 60.396 (9/7/02 VERSION) THAT CONTAINS PHOTOGRAPHS OF THE FACILITY AND A DESCRIPTION OF ANY PROBLEMS DETECTED DURING THE ANNUAL VISUAL MONITORING.

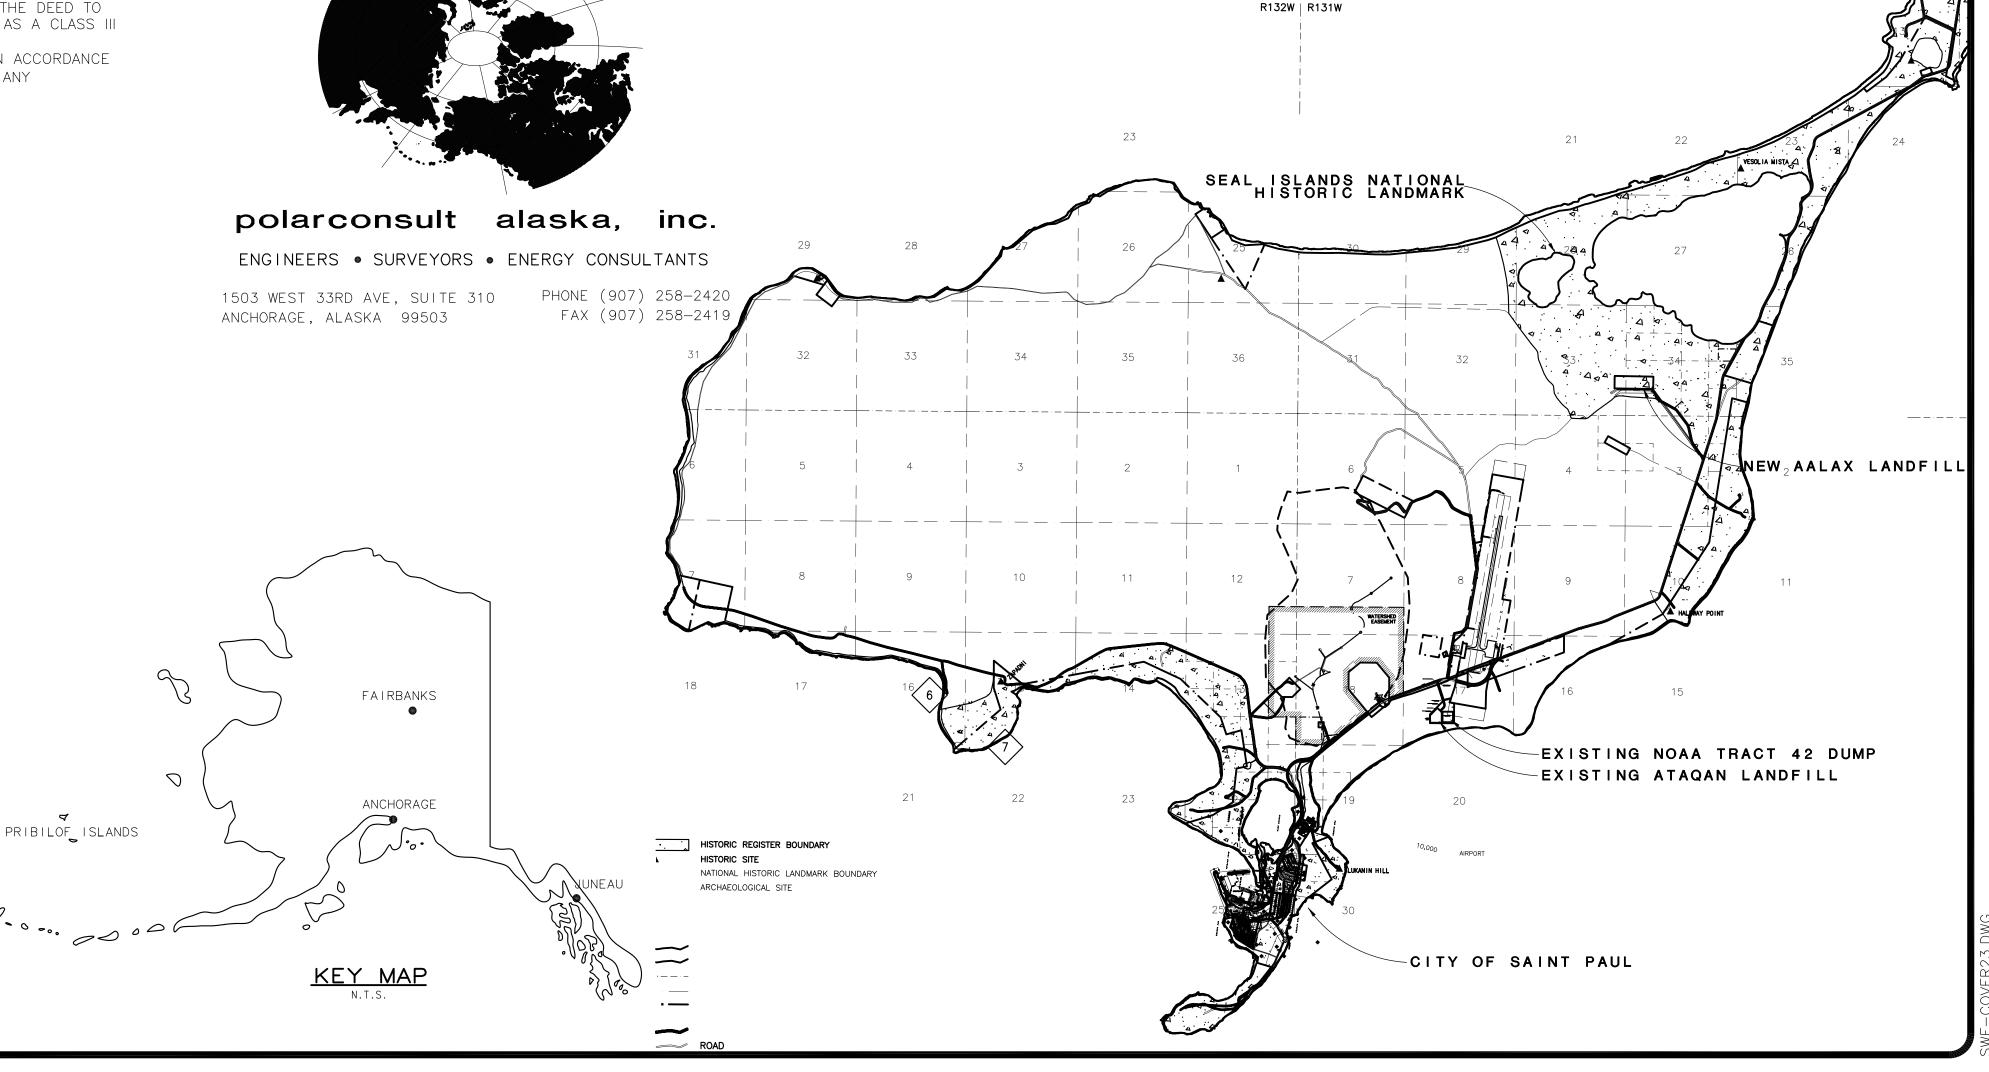

SHEET INDEX

- C-1 NOT PART OF THIS PLAN SET
- C-2 AALAX SITE EXISTING CONDITIONS AND SITE SURVEY CONTROL C-3 AALAX SITE PLAN AND MATERIAL QUANTITY ESTIMATES
- C-4 AALAX SITE GRADING
- C-5 NOT PART OF THIS PLAN SET
- C-6 NOT PART OF THIS PLAN SET
- C-7 AALAX LANDFILL SECTIONS
- C-8 NOT PART OF THIS PLAN SET
- C-9 NOT PART OF THIS PLAN SET

- C-10 NOT PART OF THIS PLAN SET
- C-11 NOT PART OF THIS PLAN SET C-12 NOT PART OF THIS PLAN SET
- C-13 PIPE AND CHAIN-LINK FENCE DETAILS
- C-14 FENCE DETAILS
- C-15 SIGN DETAILS R-2 NEW LANDFILL SITE ACCESS ROAD DETAILS
- R-10 NEW LANDFILL SITE ACCESS ROAD PLAN AND PROFILE
- PLAT 2001-7 AALAX S/D (WITH 100 FT. ACCESS ROW DEDICATION)
- PLAT 2013-28 OLD TRUCK DUMP S/D (NEW 40-FT. ROW DEDICATION, AND

PARTIAL VACATION OF 100 FT. ROW DEDICATED IN PLAT 2001-7)

BURN BOX AND ASSOCIATED SITE IMPROVEMENTS -AALAX LANDFILL SUPPORT BUILDING -

SEE PLANS BY OTHERS SEE PLANS BY OTHERS

GENERAL SURVEY NOTES:

1. EXISTING GROUND CONTOURS BASED ON 2002 SURVEY BY SLANA SURVEYS AND 2001 USGS AERIAL LIDAR SURVEY OF ST. PAUL ISLAND. DATUM FOR CONTOURS IS MEAN LOW

2. CONTRACTOR TO VERIFY CURRENT HORIZONTAL AND VERTICAL VALIDITY OF SITE CONTROL TO OWNER'S SATISFACTION BEFORE COMMENCING CONSTRUCTION.

- 1. SURVEY DATUM IS ALASKA STATE PLANE ZONE 9, NAD83 IN U.S. SURVEY FEET, WITH NGS PID UW0219 "SOUTHWEST BASE RESET" (CONTROL POINT 1, CP1) AS:
- N: 1,151,412.99' (350,954.948 METERS) E: 1,591,067.78' (484,963.355 METERS)
- 2. HORIZONTAL CONTROL IS AALAX S/D WC 2 (CP23) WITH COORDINATES:
- N: 1,166,442.63
- E: 1,603,158.41

AND BASIS OF BEARING IS THE NORTHERLY LOT LINE OF AALAX S/D BETWEEN WC 2 (CP 23) AND COR 1 (CP 22) AS SHOWN HEREIN AND ESTABLISHED ON ALEUTIAN RECORDING DISTRICT PLAT 2001-7.


- 3. VERTICAL CONTROL BASIS OF ELEVATION IS A STANDARD NOS DISK STAMPED "SNP 1987" ELEVATION = 28.88' MLLW IN NOS VERTICAL DATUM EFFECTIVE IN NOV. 2002. CONTOURS AND ELEVATIONS ARE BASED ON MLLW = 0.00'. LOCAL CONTROL IS NDICATED ELEVATIONS OF LOCAL SURVEY CONTROL MONUMENTS.
- 4. PROJECT IS LOCATED WITHIN EXISTING PLATTED SUBDIVISIONS:
 - a. AALAX SUBDIVISION, ALEUTIAN RECORDING DISTRICT PLAT NO. 2001-7.
- b. OLD TRUCK DUMP SUBDIVISION, ALEUTIAN RECORDING DISTRICT PLAT NO. 2013–28, INCORPORATED BY REFERENCE.

	CONTROL MON	NUMENT	S	
CONTROL POINT #	MONMUENT NAME	X (EASTING)	Y (NORTHING)	Z (MTL)
1	SOUTHWEST BASE RESET (NGS PID UW0219)	1,591,067.78	1,151,412.99	42.29
2	NE AIRPORT PROP. LINE	1,597,806.85	1,161,425.13	78.02
3	NORTH POLOVINA HILL (USC&GS, 1951)	1,601,859.92	1,162,927.73	472.41
4	BM6 (SNP or SNP-'B' NOS)	1,596,115.10	1,153,783.38	28.88
16	TCM 12	1,606,390.73	1,162,698.13	61.46
17	TCM 13	1,605,690.36	1,164,377.66	75.43
18	TCM 14	1,164,421.91	1,165,839.59	78.03
19	AALAX S/D SE PROPERTY CORNER MONUMENT	1,603,997.89	1,165,839.59	78.03
20	AALAX S/D SOUTH PROPERTY LINE MONUMENT	1,603,253.06	1,165,847.87	79.81
21	AALAX S/D SW PROPERTY CORNER MONUMENT	1,602,150.31	1,165,861.10	88.27
22	AALAX S/D NE PROPERTY CORNER MONUMENT	1,604,001.85	1,166,432.96	63.48
23	AALAX S/D NORTH PROPERTY LINE MONUMENT	1,603,158.41	1,166,442.63	88.24
24	AALAX S/D NW PROPERTY CORNER MONUMENT	1,602,157.06	1,166,454.93	73.66
32	MONUMENT	1,164,586.20	1,607,613.16	37.21
33	WP-60P	1,164,524.87	1,607,517.91	71.62
34	WP	1,165,861.10	1,602,150.31	88.27
35	SECTION CORNER	1,164,574.24	1,597,383.60	76.58
36	1/2" REBAR	1,160,094.92	1,597,745.39	79.26
37	AIRPORT EAST PROP. LINE MONUMENT	1,155,672.97	1,597,236.72	19.66
38	ASLS 89-101 TR-2 LS 5481	1,153,919.62	1,596,485.22	NA
39	ASLS 89-101 TR-2 AP5 TR40 ARPT. PLAT MON.	1,153,919.62	1,596,485.22	NA
40	3950-S BLK L3 MONUMENT	1,153,192.15	1,596,642.88	24.46
41	6" SPIKE	1,165,861.10	1,602,150.31	88.27
42	1/2" REBAR	1,151,676.25	1,593,315.38	9.55
43	T35S R131W, TR43 PROP. CORNER, BLM MON.	1,150,787.28	1,591,475.37	10.29
44	TR43 AP7 S18 PROP. CORNER, BLM MON.	1,150,086.96	1,590,641.39	22.12
45(b)	AIRPORT PLAT WEST PROP. LINE MONUMENT	1,159,634.36	1,595,983.80	NA
46(b)	AIRPORT PLAT WEST PROP. LINE MONUMENT	1,161,674.97	1,596,330.61	NA

HORIZONTAL COORDINATES ARE IN AK ZONE 9 NAD 83 U.S. SURVEY FEET.
VERTICAL COORDINATES ARE IN FEET RELATIVE TO MEAN LOWER LOW WATER (NOAA, 1977)
NA = NOT AVAILABLE

NA = NOT AVAILABLE
(a) = ELEVATION REPORTED BY DOWL DURING SURVEY OF ST. PAUL AIRPORT PLAT (2003)
(b) = POINT SURVEYED BY DOWL DURING SURVEY OF ST. PAUL AIRPORT PLAT (2003)
ADDITIONAL SURVEY MONUMENTS PROVIDED FOR REFERENCE ONLY.


SITE SURVEY CONTROL NOTES SCALE: NTS

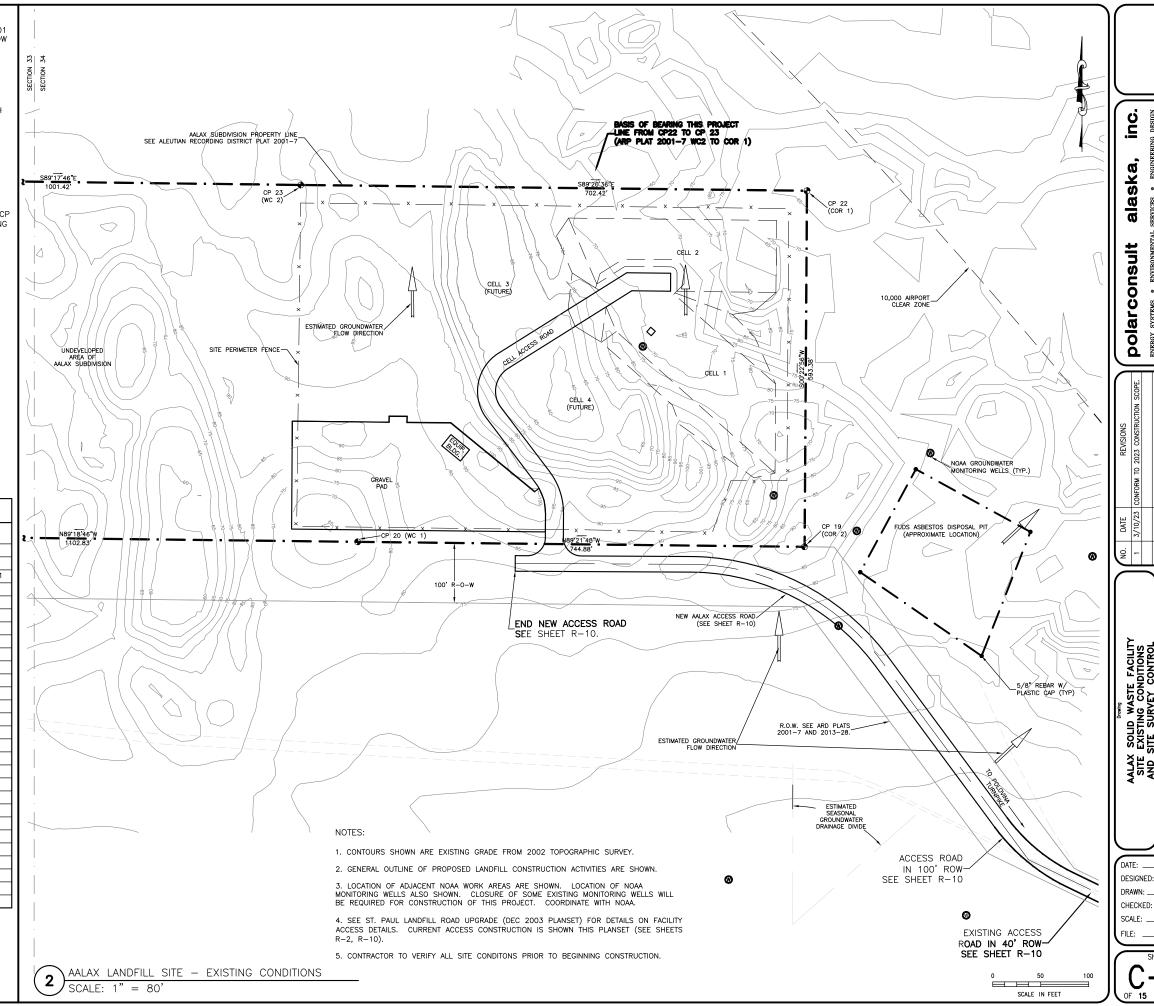

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PROJECT MATERIAL ESTIMATES						
GRADING	CUT	FILL	BORROW	NOTES		
OPERATION	(CYDS)	(CYDS)	(CYDS)			
LANDFILL INITIAL CONSTRUCTION						
AALAX ACCESS ROAD (REMAINING PORTION, APPROX STA 34+00 TO 45+00)						
GRUBBING	3,500			(NOTE 1)		
SUBBASE		15,100		SAND FROM CELL CONST.		
BASE COURSE			2,100	SCORIA		
SURFACE COURSE			600	D-1		
SIDESLOPE VEG		3,500		(NOTE 1)		
PAD CONSTRUCTION	28,211	2,970	0	SITE GRADING		
CELL ACCESS ROAD	19,471	443		EXCESS TO ROAD CONST.		
CELL 1 GRADING	27,924	161		EXCESS TO ROAD CONST.		
CELL 2 GRADING	7,300	600				
PAD SUBBASE			3,314	SCORIA		
PAD SURFACE COURSE			1,105	D-1 OR SCORIA		
ROAD SUBBASE			1,119	SCORIA		
ROAD SURFACE COURSE			257	D-1		

CELL 1 COVER	2,980	SAND
CELL 1 TOPSOIL	993	TOPSOIL
CELL 2 COVER	3,132	SAND
CELL 2 TOPSOIL	1,044	TOPSOIL
CELL 3 COVER	2,780	SAND
CELL 3 TOPSOIL	926	TOPSOIL
CELL 4 COVER	5,394	SAND
CELL 4 TOPSOIL	1,798	TOPSOIL

- NOTES:

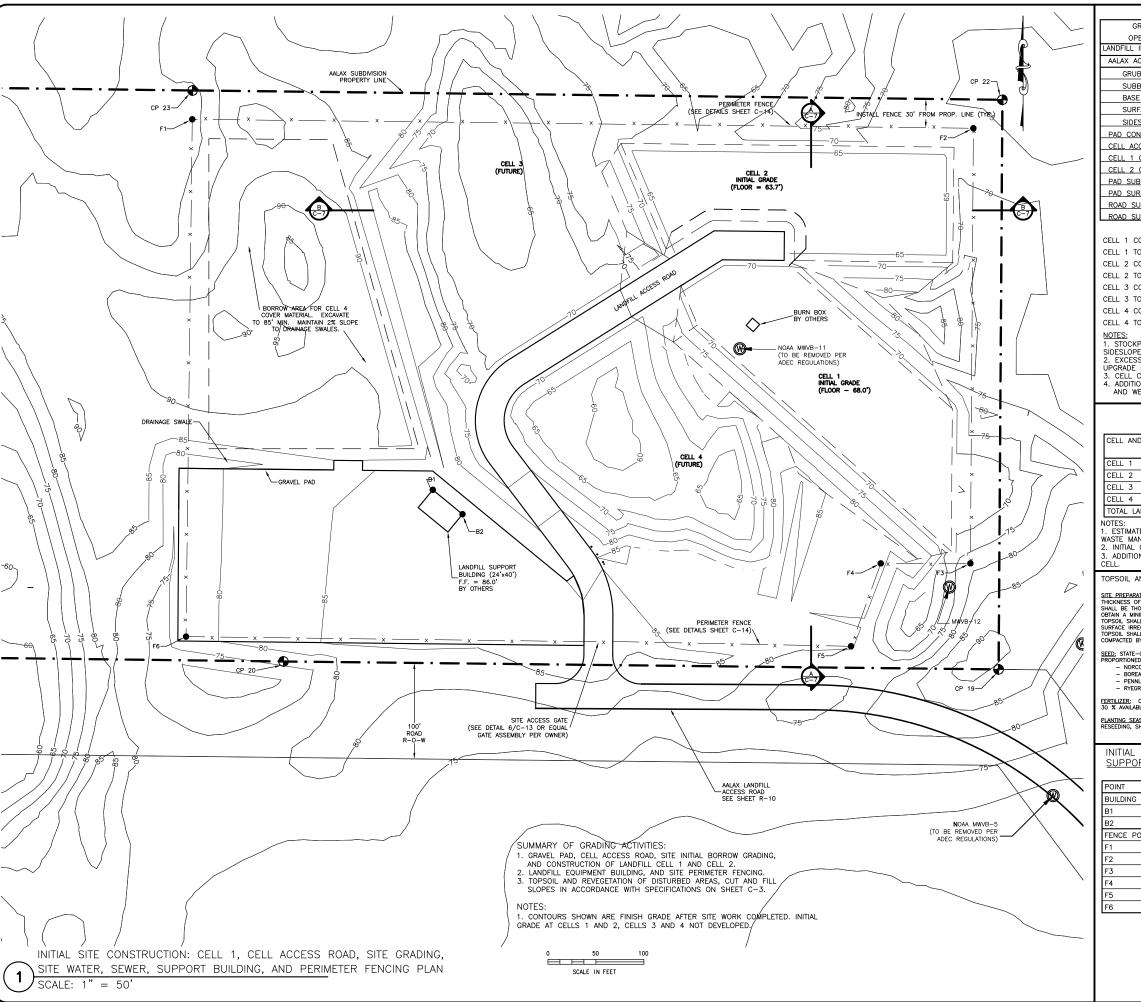 1. STOCKPILE ROAD FOOTPRINT GRUBBING ORGANICS FOR REVEGETATION OF ROAD CUT/FILL SIDESLOPES.
- SIDESLUPES.

 2. EXCESS CUT MATERIAL FROM INITIAL PAD AND CELL TO BE USED FOR AALAX ROAD UPGRADE CONSTRUCTION.

 3. CELL CLOSURE FINAL COVER IS FROM NEXT ADJACENT FUTURE CELL.

 4. ADDITIONAL COVER MATERIAL IS FROM BORROW AREA NORTH OF LANDFILL BUILDING
- AND WEST OF CELL 3.

CELL CAPACITY AND LIFE ESTIMATES

(CYDS) 19,994	(CYDS) 12,796	(CYDS) 7,198	(YEARS, NOTE 1) 10.8
19,994	12,796	7,198	10.8
19,372	12,398	6,974	10.5
19,690	12,602	7,088	10.6
49,339	31,577	17,762	26.6
100 705	69,373	39,022	58.5
_	49,339 108,395		· · · · · · · · · · · · · · · · · · ·

NOTES:

1. ESTIMATED CELL LIFE BASED ON 1,186 CYD OF MSW PER YEAR. SEE DEC 2004 SOLID WASTE MANAGEMENT PLAN FOR BASIS.

2. INITIAL COVER MATERIAL FOR ALL CELLS IS OBTAINED FROM CELL FLOOR.

3. ADDITIONAL CELL COVER MATERIAL IS OBTAINED FROM OVERBURDEN FROM NEXT/FUTURE

TOPSOIL AND VEGETATION SPECIFICATION:

SITE PREPARATION: DISTRIBUTE AND SPREAD TOPSOIL EVENLY TO AN AVERAGE THICKNESS OF SIX INCHES WITH A MINIMUM THICKNESS OF FOUR INCHES. WHEN ORGANIC CONTENT OF THE TOPSOIL EXCEEDS 11% BY DRY WEIGHT, THE TOPSOIL SHALL BE THOROUGHLY INCORPORATED INTO THE UNDERTHING SOIL USING A ROTARY THLER OR SIMILAR EQUIPMENT TO OBTAIN A MINIMUM B INCH LAYER OF WELL MIXED MATERIAL NOT EXCEEDING 11% DRY WEIGHT OF ORGANIC MATERIAL TOPSOIL SHALL BE SPREAD AND MIXED SO PLANTING CAN PROCEED WITH LITTLE ADDITIONAL SOIL PERFATION OR TILLAGE. SUFFACE IRREGULARITIES RESULTING FROM TOPSOILUNG OR OTHER OPERATIONS SHALL BE LEVELED TO PREVENT DEPRESSIONS. TOPSOIL SHALL NOT BE PLACED WHEN THE SUBGRADE IS FROZEN, EXCESSIVELY WET OR DRY OR COMPACTED. TOPSOIL COMPACTED BY CONSTRUCTION EQUIPMENT SHALL BE AREATED TO A MINIMUM DEPTH OF 2 INCHES BEFORE SEEDING.

SEED: STATE-CERTIFIED SEED OF THE LATEST SEASON'S CROP WITH A MINIMUM OF 80% LIVE SEED. SEED MIX SHALL BE PROPORTIONED BY AS FOLLOWS:

- NORCOAST BERNING HAIRCRASS (DESCHAMPSIA BERINGENSIS)
- BOREAL, RED FESCUE (FESTUCA RUBRA BOREAL)
- PENNLAWN RED FUSCUE (FESTUCA RUBRA PENNLAWN)
- RYEGRASS (LOLIUM MULTIFLORUN)

36. LBS PER ACRE (BY WEIGHT)
- RYEGRASS (LOLIUM MULTIFLORUN)

F<u>ERTILIZER:</u> COMMERCIAL GRADE FREE FLOWING, CONTAINING A MINIMUM PERCENTAGE BY WEIGHT OF 14 % NITROGEN, 30 % AVAILABLE PHOSPHORIC ACID, AND 14 % POTASH. APPLY UNIFORMLY AT A RATE OF 375 POUNDS PER ACRE.

INITIAL CONSTRUCTION SITE FEATURE POINTS SUPPORT BUILDING, AND PERIMETER FENCING

POINT	NORTHING (FT)	EASTING (FT)	ELEVATION (FT)	DESCRIPTION		
BUILDING FOOTPRINT POINTS						
B1	1,166,026.64	1,603,408.64	85.20	N BLDG COR.		
B2	1,166,001.26	1,603,439.55	85.20	E BLDG COR.		
FENCE POINTS						
F1	1,166,412.63	1,603,158.04	EG	FENCE CORNER		
F2	1,166,403.31	1,603,971.65	EG	FENCE CORNER		
F3	1,165,950.06	1,603,968.54	EG	FENCE CORNER		
F4	1,165,950.01	1,603,875.20	FG	FENCE CORNER		
F5	1,165,863.71	1,603,844.22	FG	FENCE CORNER		
F6	1,165,873.76	1,603,151.57	FG	FENCE CORNER		

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SOLID WASTE FACILITY
MATERIAL QUANTITY ESTIMATES Project
. – SOLID WASTE
. WASTE FACILITY
Poul, Alaska PAUL SOLID Saint P AALAX :


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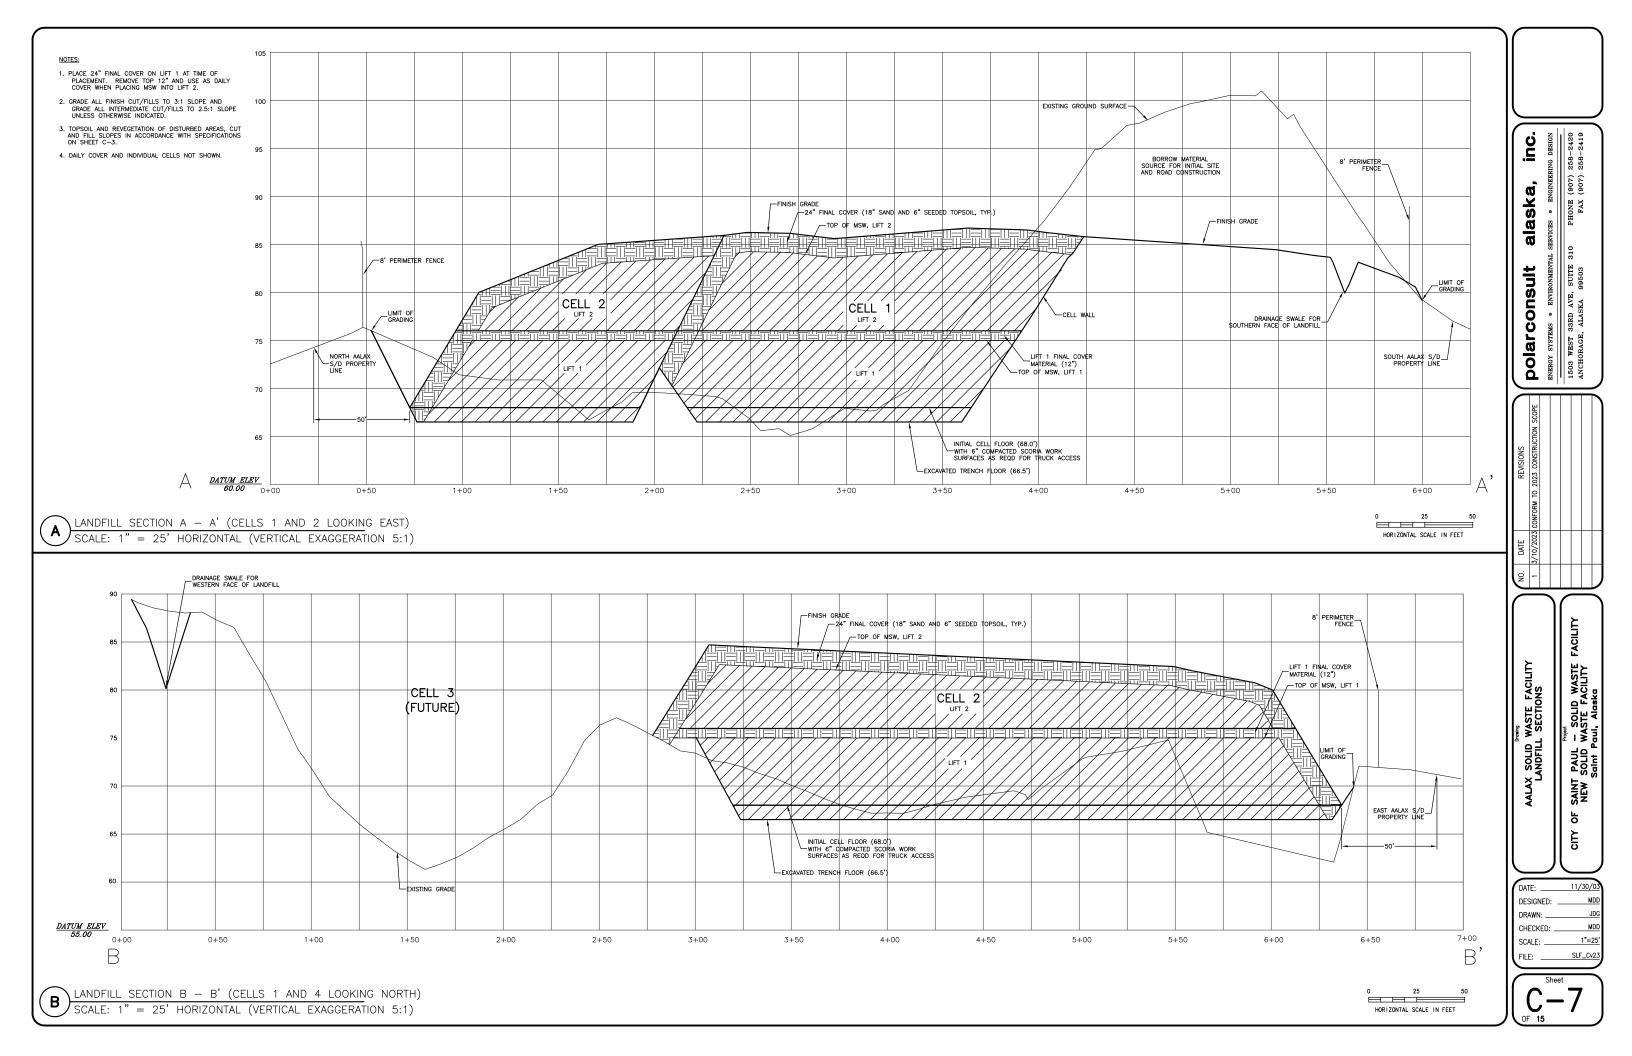
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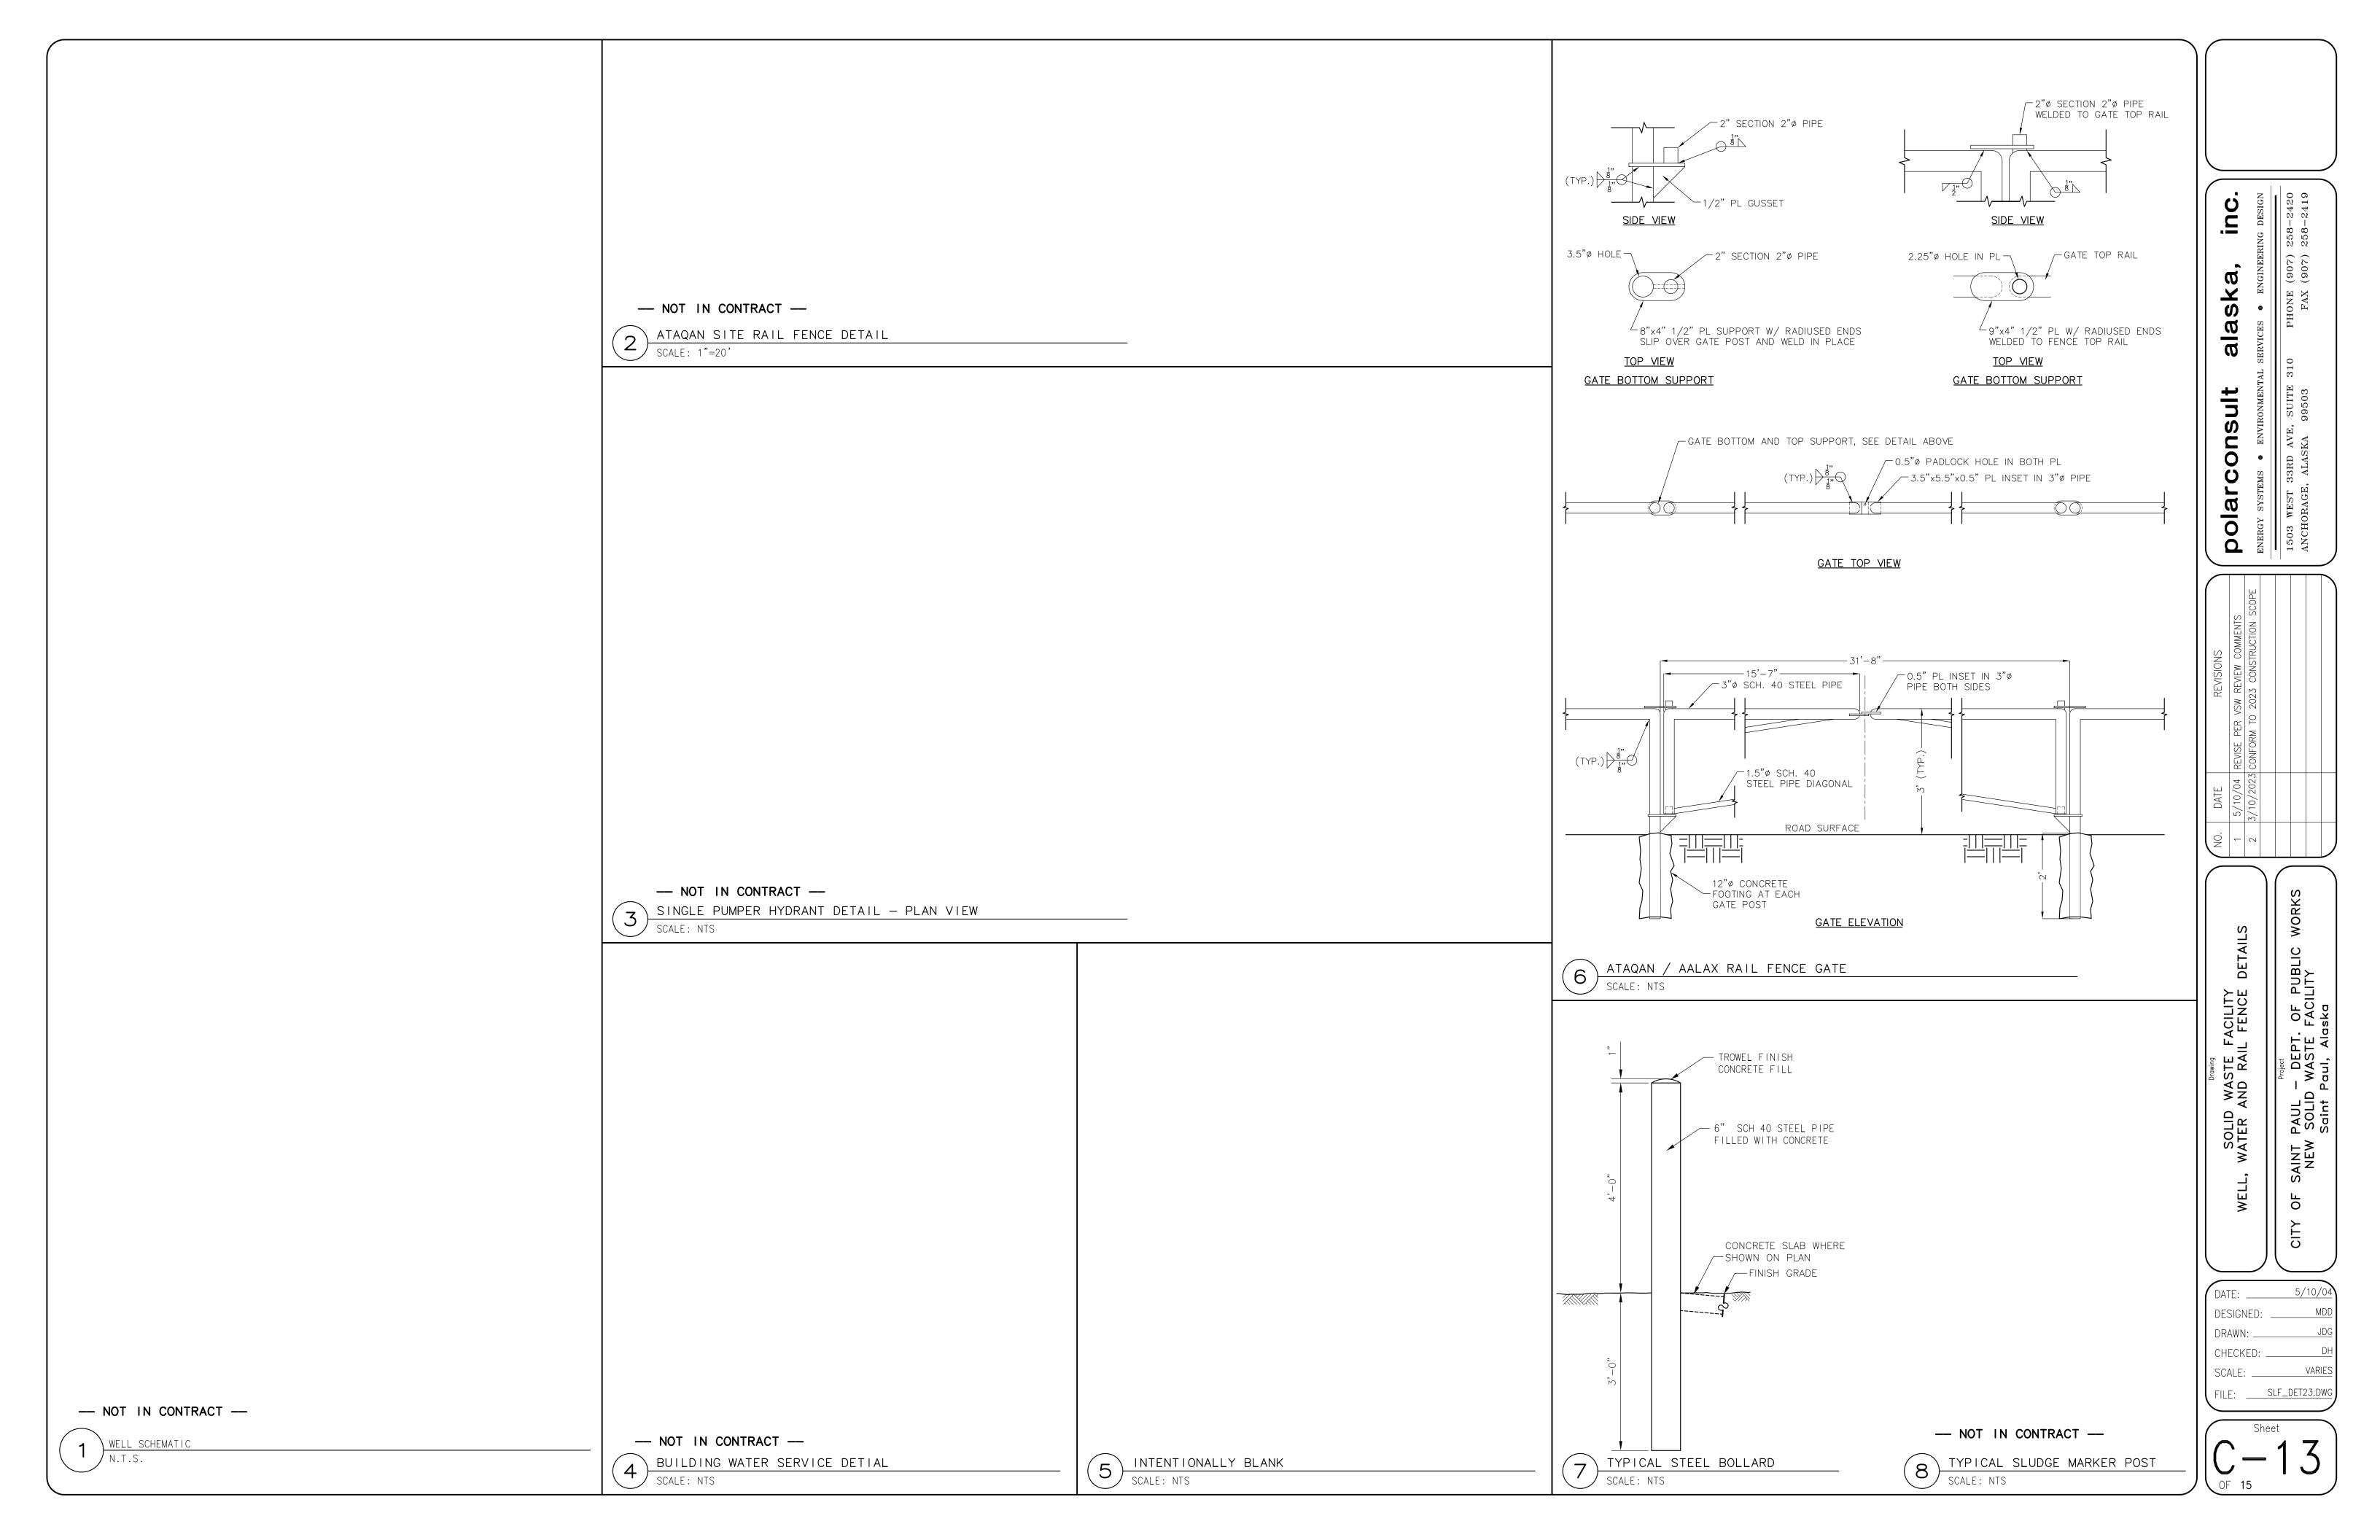
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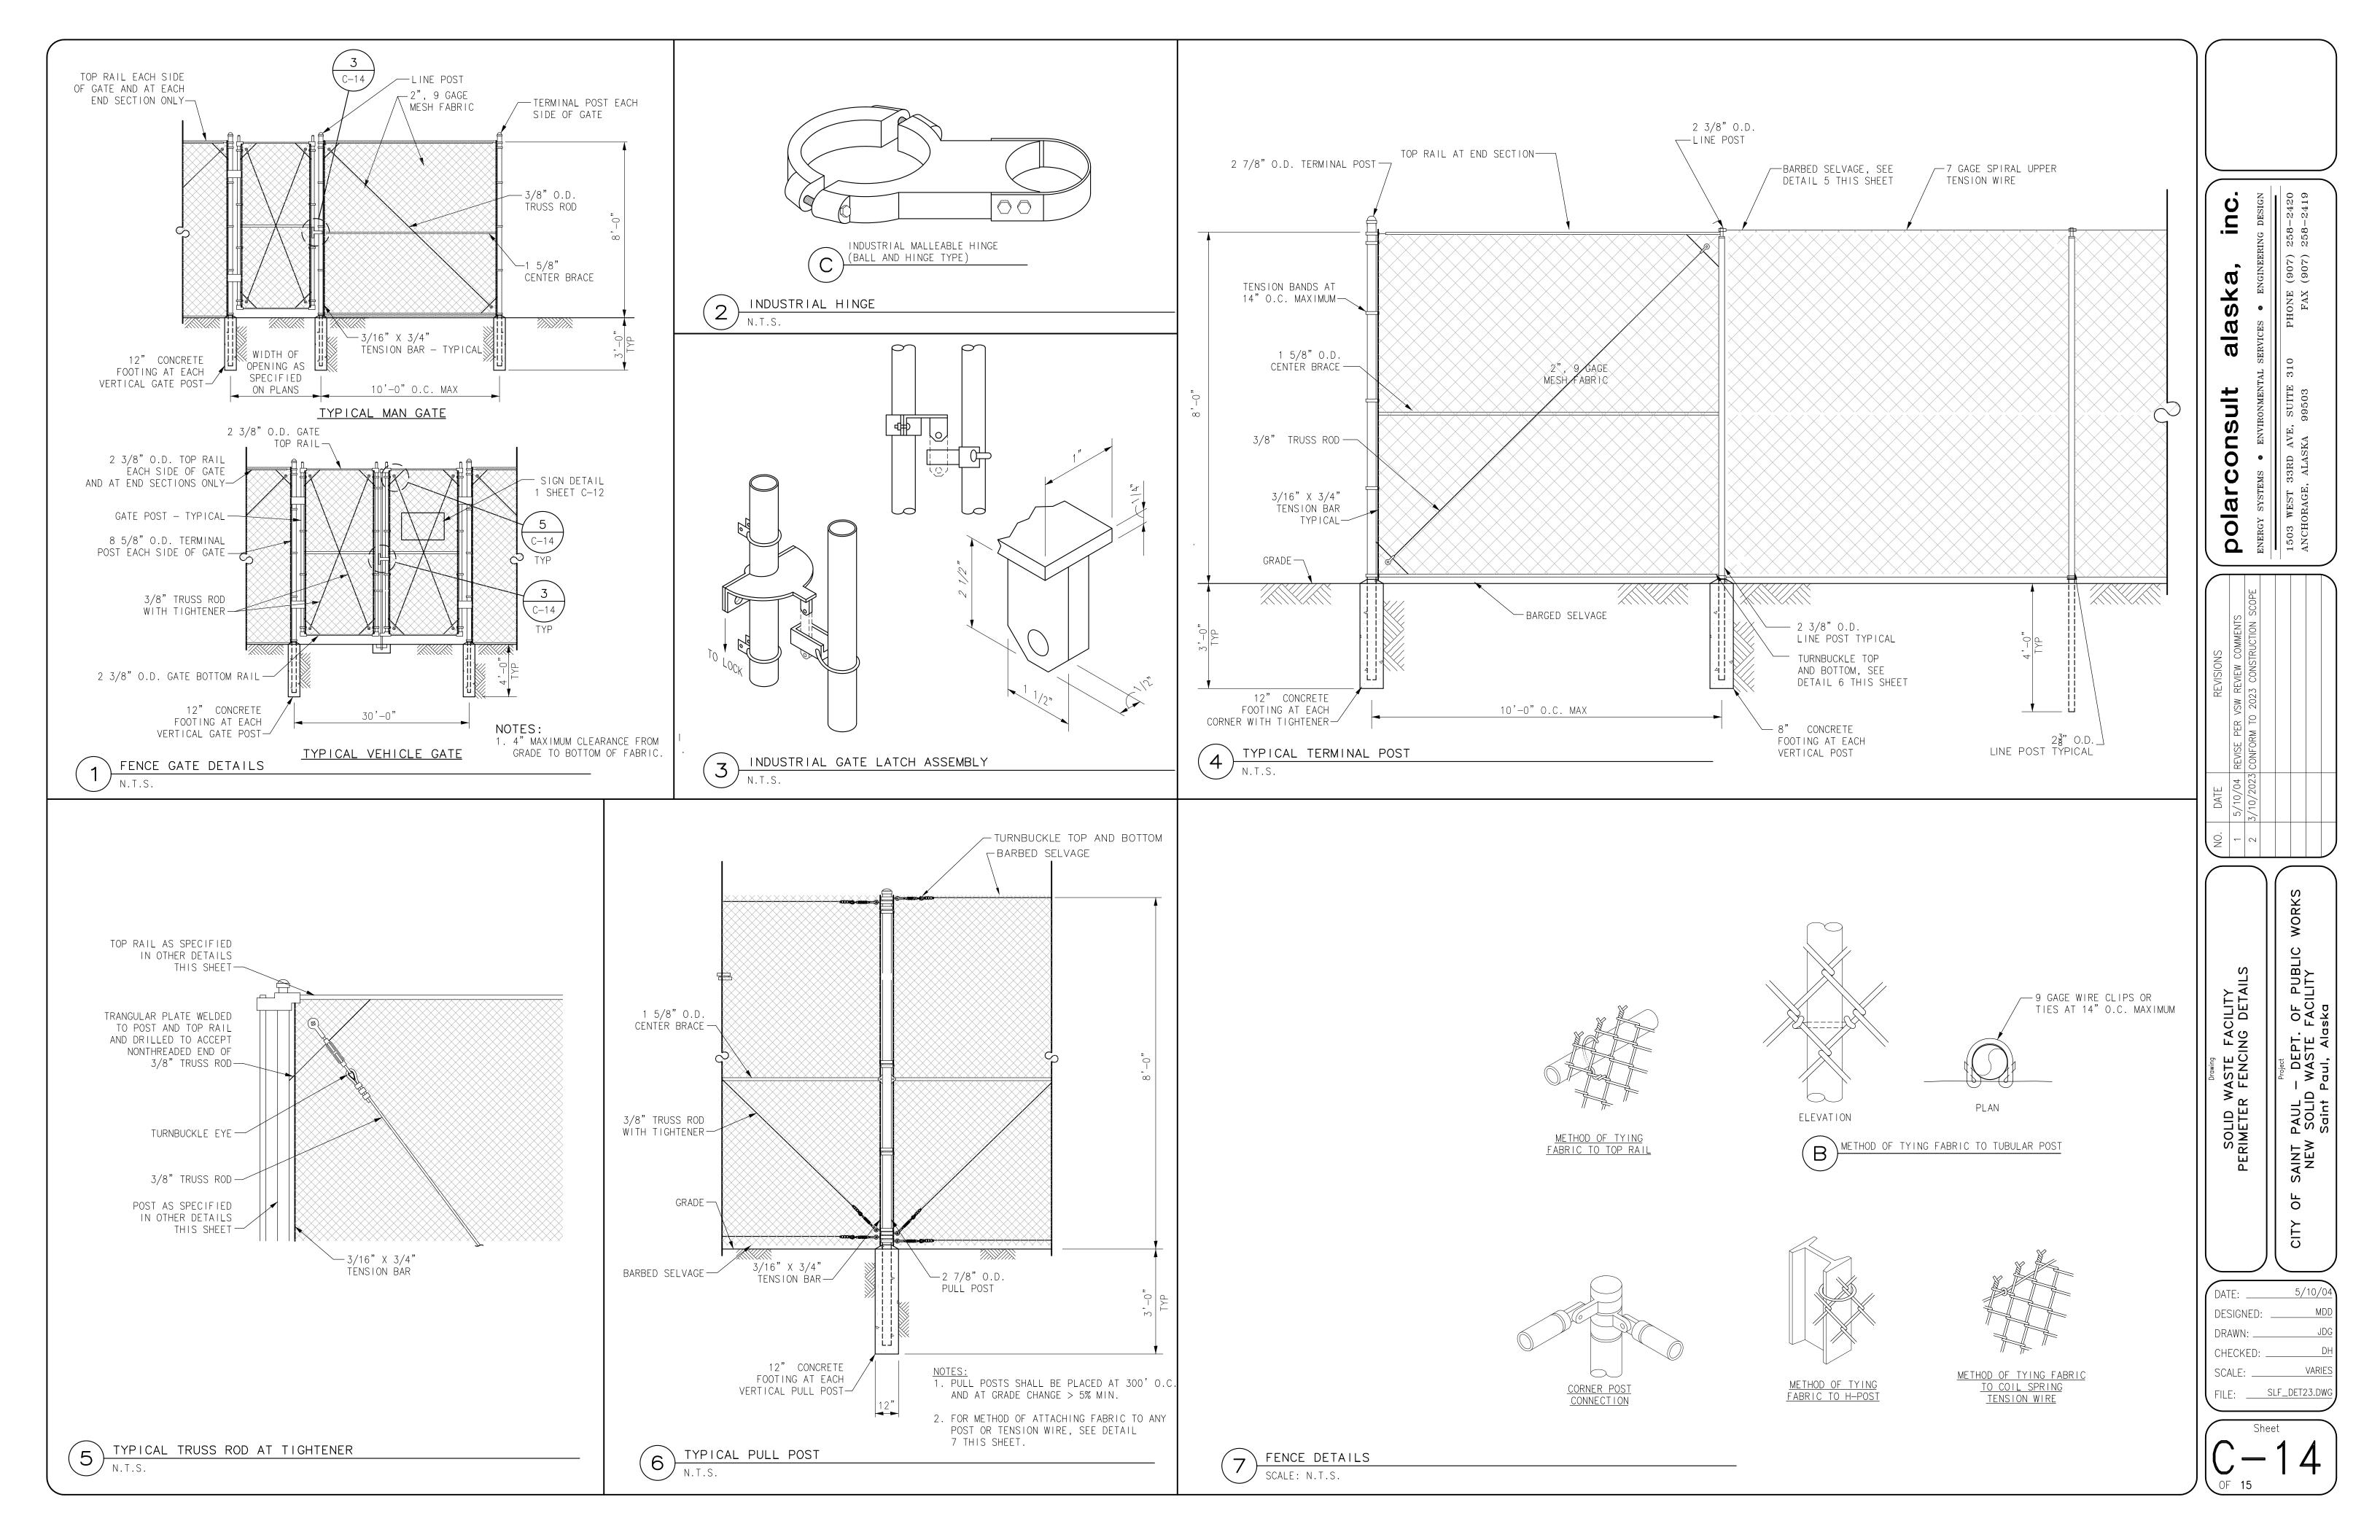
SITE









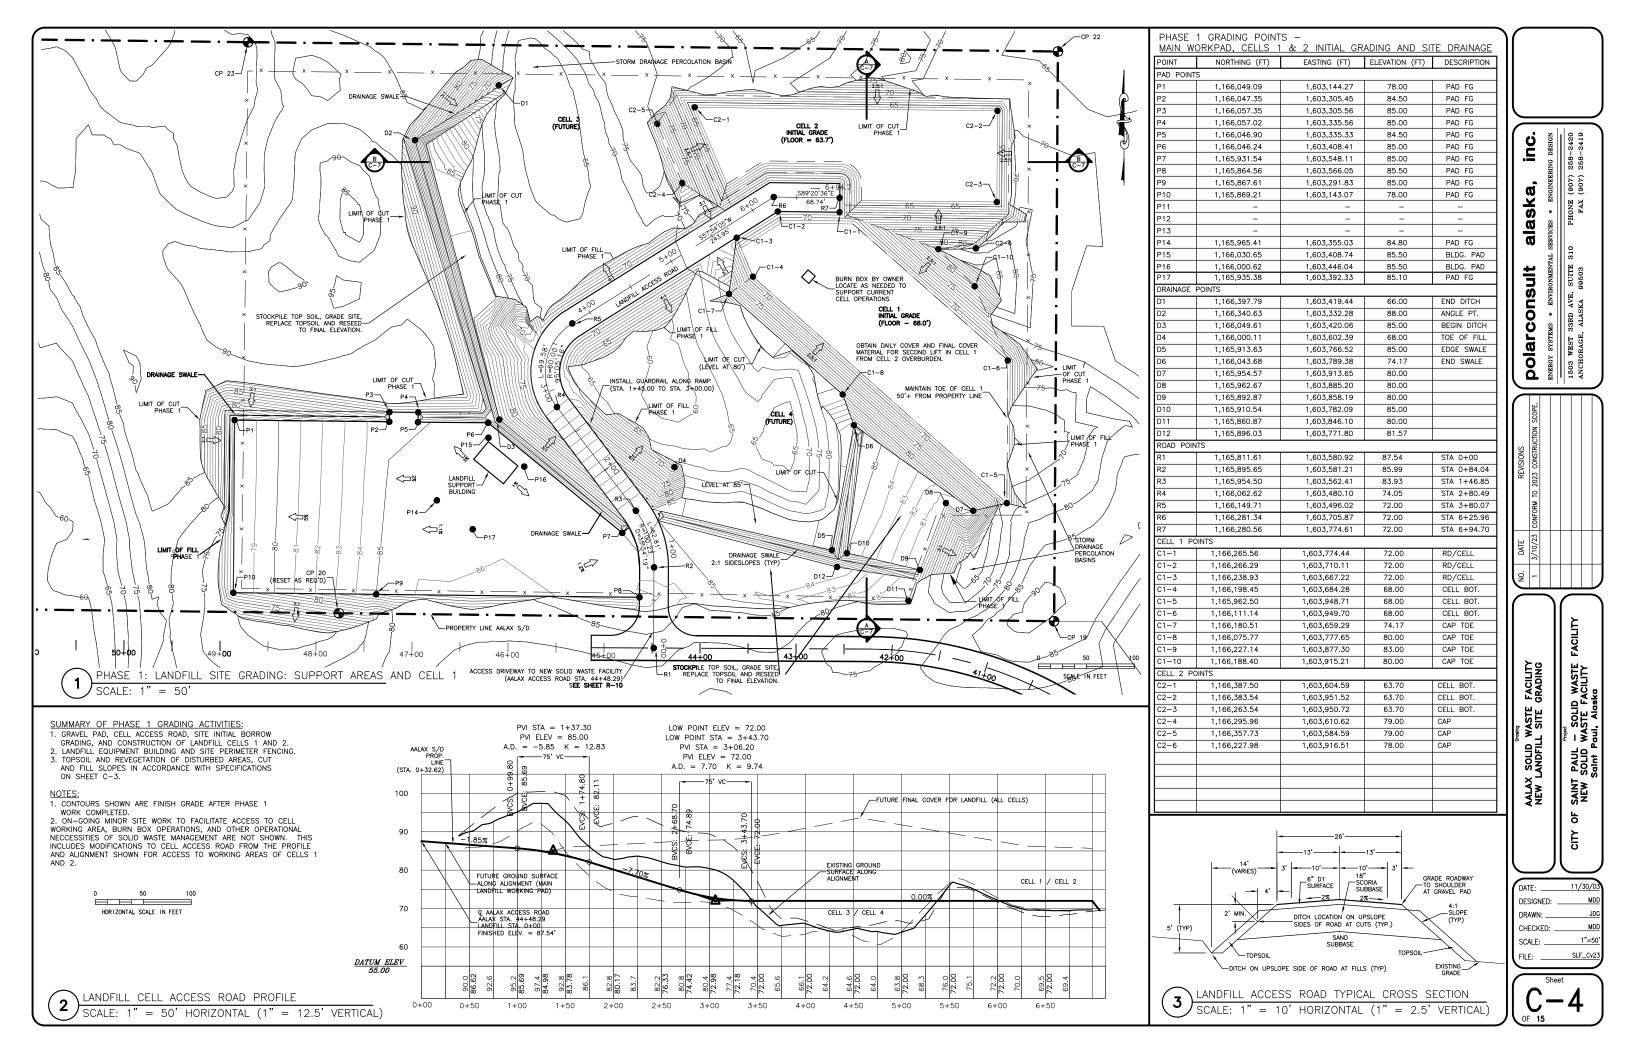



1. "RESTRICTED ENTRY" SIGN SHALL HAVE WHITE REFLECTIVE SHEETING BACKGROUND, WITH RED LETTERS.

- 2. "RESTRICTED ENTRY" SIGNS SHALL BE PLACED IN THE CENTER OF ALL GATES INSTALLED UNDER THIS CONTRACT.
- 3. SIGNS SHALL ALSO BE INSTALLED ON "STANDARD" SIGN POSTS OR MOUNTED ON PERIMETER FENCE AT LOCATION SHOWN ON THE PLANS.

"RESTRICTED ENTRY" SIGN PLATE SCALE: 1"=6" FILE: SIGN1.DWG

FASTENER SPECIFICATIONS

FA	STENERS	ALUMINUM	STEEL	STAINLESS STEEL
BOLTS	MACHINE CARRIAGE, "U"	2024-T4	A-307	A-276
NUTS	REGULAR LOCK	6061-T6 2017-T4	A-307	A-276
WASHERS		2024-T4	A-36	A-276
"J" BOLTS				A-276
POST CLIPS		356-T6		

NOTES:

1. DETAILS SHOWN ARE TO INDICATE GENERAL DESIGN ONLY. DIMENSIONS AND DESIGN MAY VARY AMONG MANUFACTURERES.

2. TOP OF POST MOUNTING BRACKESTS SHALL HAVE A MINIMUM CLEARANCE OF 3" FROM

3. ALL SIGN MOUNTING FASTENERS ON SIGN FACE SHALL BE PAINTED AS CLOSELY AS POSSIBLE IN MATCHING COLOR OF SIGN FACE.

4. ALL SIGNS, ZEES, AND BRACES MOUNTED TO THE POSTS SHALL BE ATTACHED WITH 5/16" BOLTS.

5. ALL STEEL NUTS, BOLTS, AND WASHERS SHALL BE GALVANIZED TO ASTM A-153.


6. ALL ALUMINUM NUTS, BOLTS, AND WASHERS SHALL BE ANODIZED.


7. SIGN SHAPES AND COLORS SHALL CONFORM TO THE ALASKA TRAFFIC MANUAL, ALASKA SIGN DESIGN SPECIFICATIONS, AND THE ALASKA STANDARD SPECIFICATIONS FOR HIGHWAY CONSTRUCTION.

8. PIPE AND TUBE POSTS SHALL HAVE A WEATHER TIGHT CAP. DRIVE CAPS SHALL BE USED ON POST BEING DRIVEN.

9. FOR SIGN FASTENER SPECIFICATIONS SEE TABLE ABOVE. MINIMUM OF 3 FASTENERS PER SIGN.



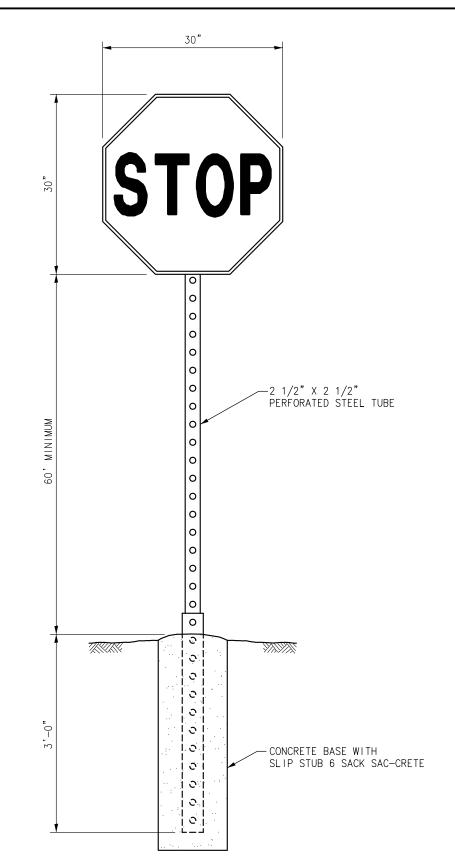

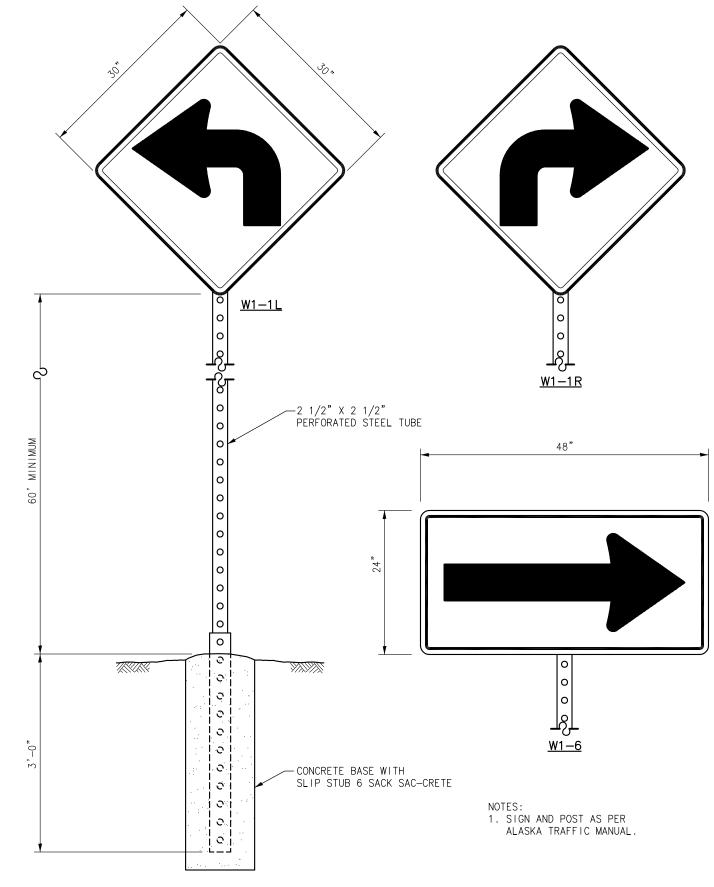


DIRECTIONAL SIGNS

SCALE: 3/4"=1'-0"

1. SIGN AND POST AS PER ALASKA TRAFFIC MANUAL.

SCALE: 3/4"=1'-0"

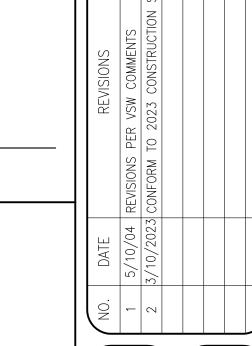

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1. ENTRANCE SIGN SHALL HAVE WHITE REFLECTIVE SHEETING BACKGROUND, WITH BLACK 1" TALL LETTERS UNLESS NOTED OTHERWISE.

2. SIGN SHALL BE MOUNTED ON TWO STANDARD SIGN POSTS. SEE DETAIL THIS SHEET.


\ ENTRANCE SIGN DETAIL SCALE: 1"=6"

SALVAGE AREA 2" LETTERS WHITE GOODS AND SCRAP METAL

1. SIGNS SHALL HAVE WHITE REFLECTIVE SHEETING BACKGROUND,

WITH 2" TALL BLACK LETTERS. 2. SIGN SHALL BE MOUNTED ON STANDARD SIGN POSTS. SEE DETAIL THIS SHEET.


DIRECTION SIGNS SCALE: 1"=6"

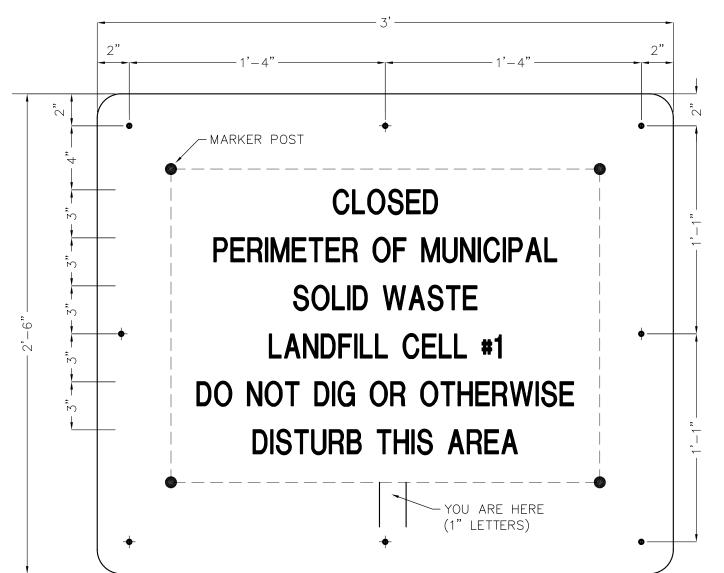

1. CLOSED CELL SIGN SHALL HAVE WHITE REFLECTIVE SHEETING BACKGROUND, WITH BLACK 1-1/2" TALL LETTERS UNLESS NOTED OTHERWISE.

2. SIGN SHALL BE MOUNTED ON TWO STANDARD SIGN POSTS. SEE DETAIL THIS SHEET. 3. POST LOCATIONS AND CELL BOUNDARY ARE DIFFERENT FOR EACH LANDFILL CELL, BOUNDARY AND POST LOCATIONS SHOWN ARE FOR REFERENCE ONLY, THE FINAL SHAPE AND DIMENSIONS OF THE CLOSED AREA SHOULD BE VERIFIED IN

THE FIELD BEFORE FABRICATION AND INSTALLATION OF SIGN.

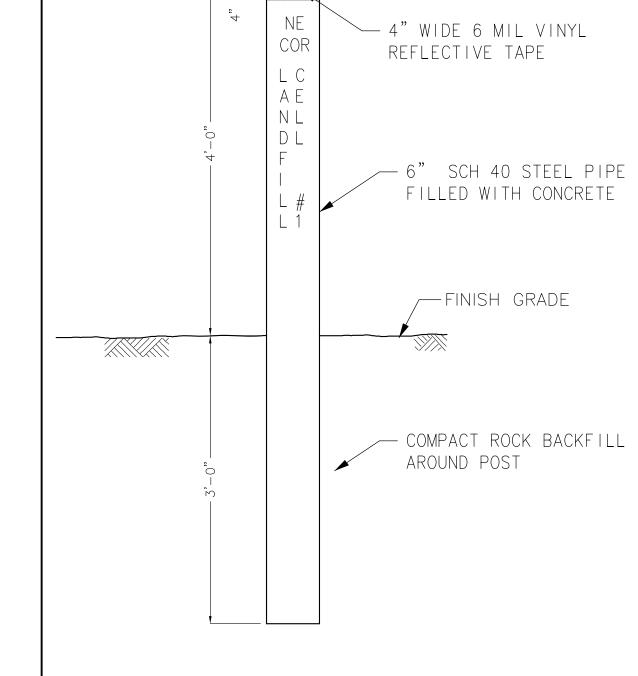

TROWEL FINISH CONCRETE FILL

LANDFILL MARKER POST DETAIL

TYPICAL CLOSED LANDFILL CELL MARKERS

FILE: SLF_DET23.DWG Sheet


DESIGNED:

CHECKED:

DRAWN:

SCALE:

SCALE: NTS

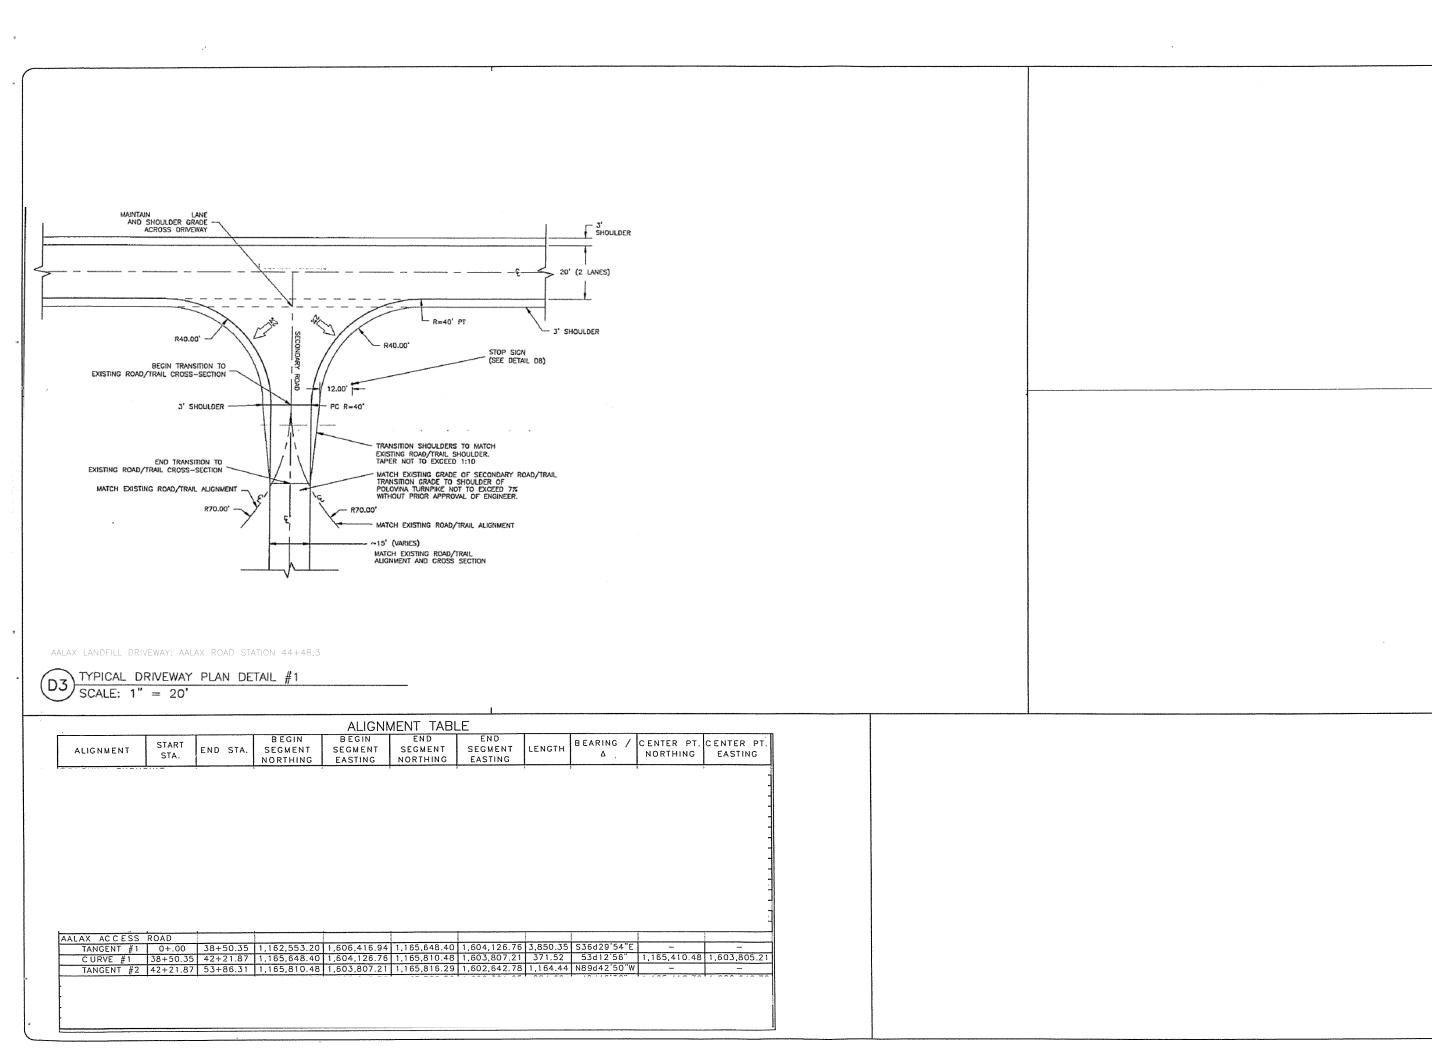



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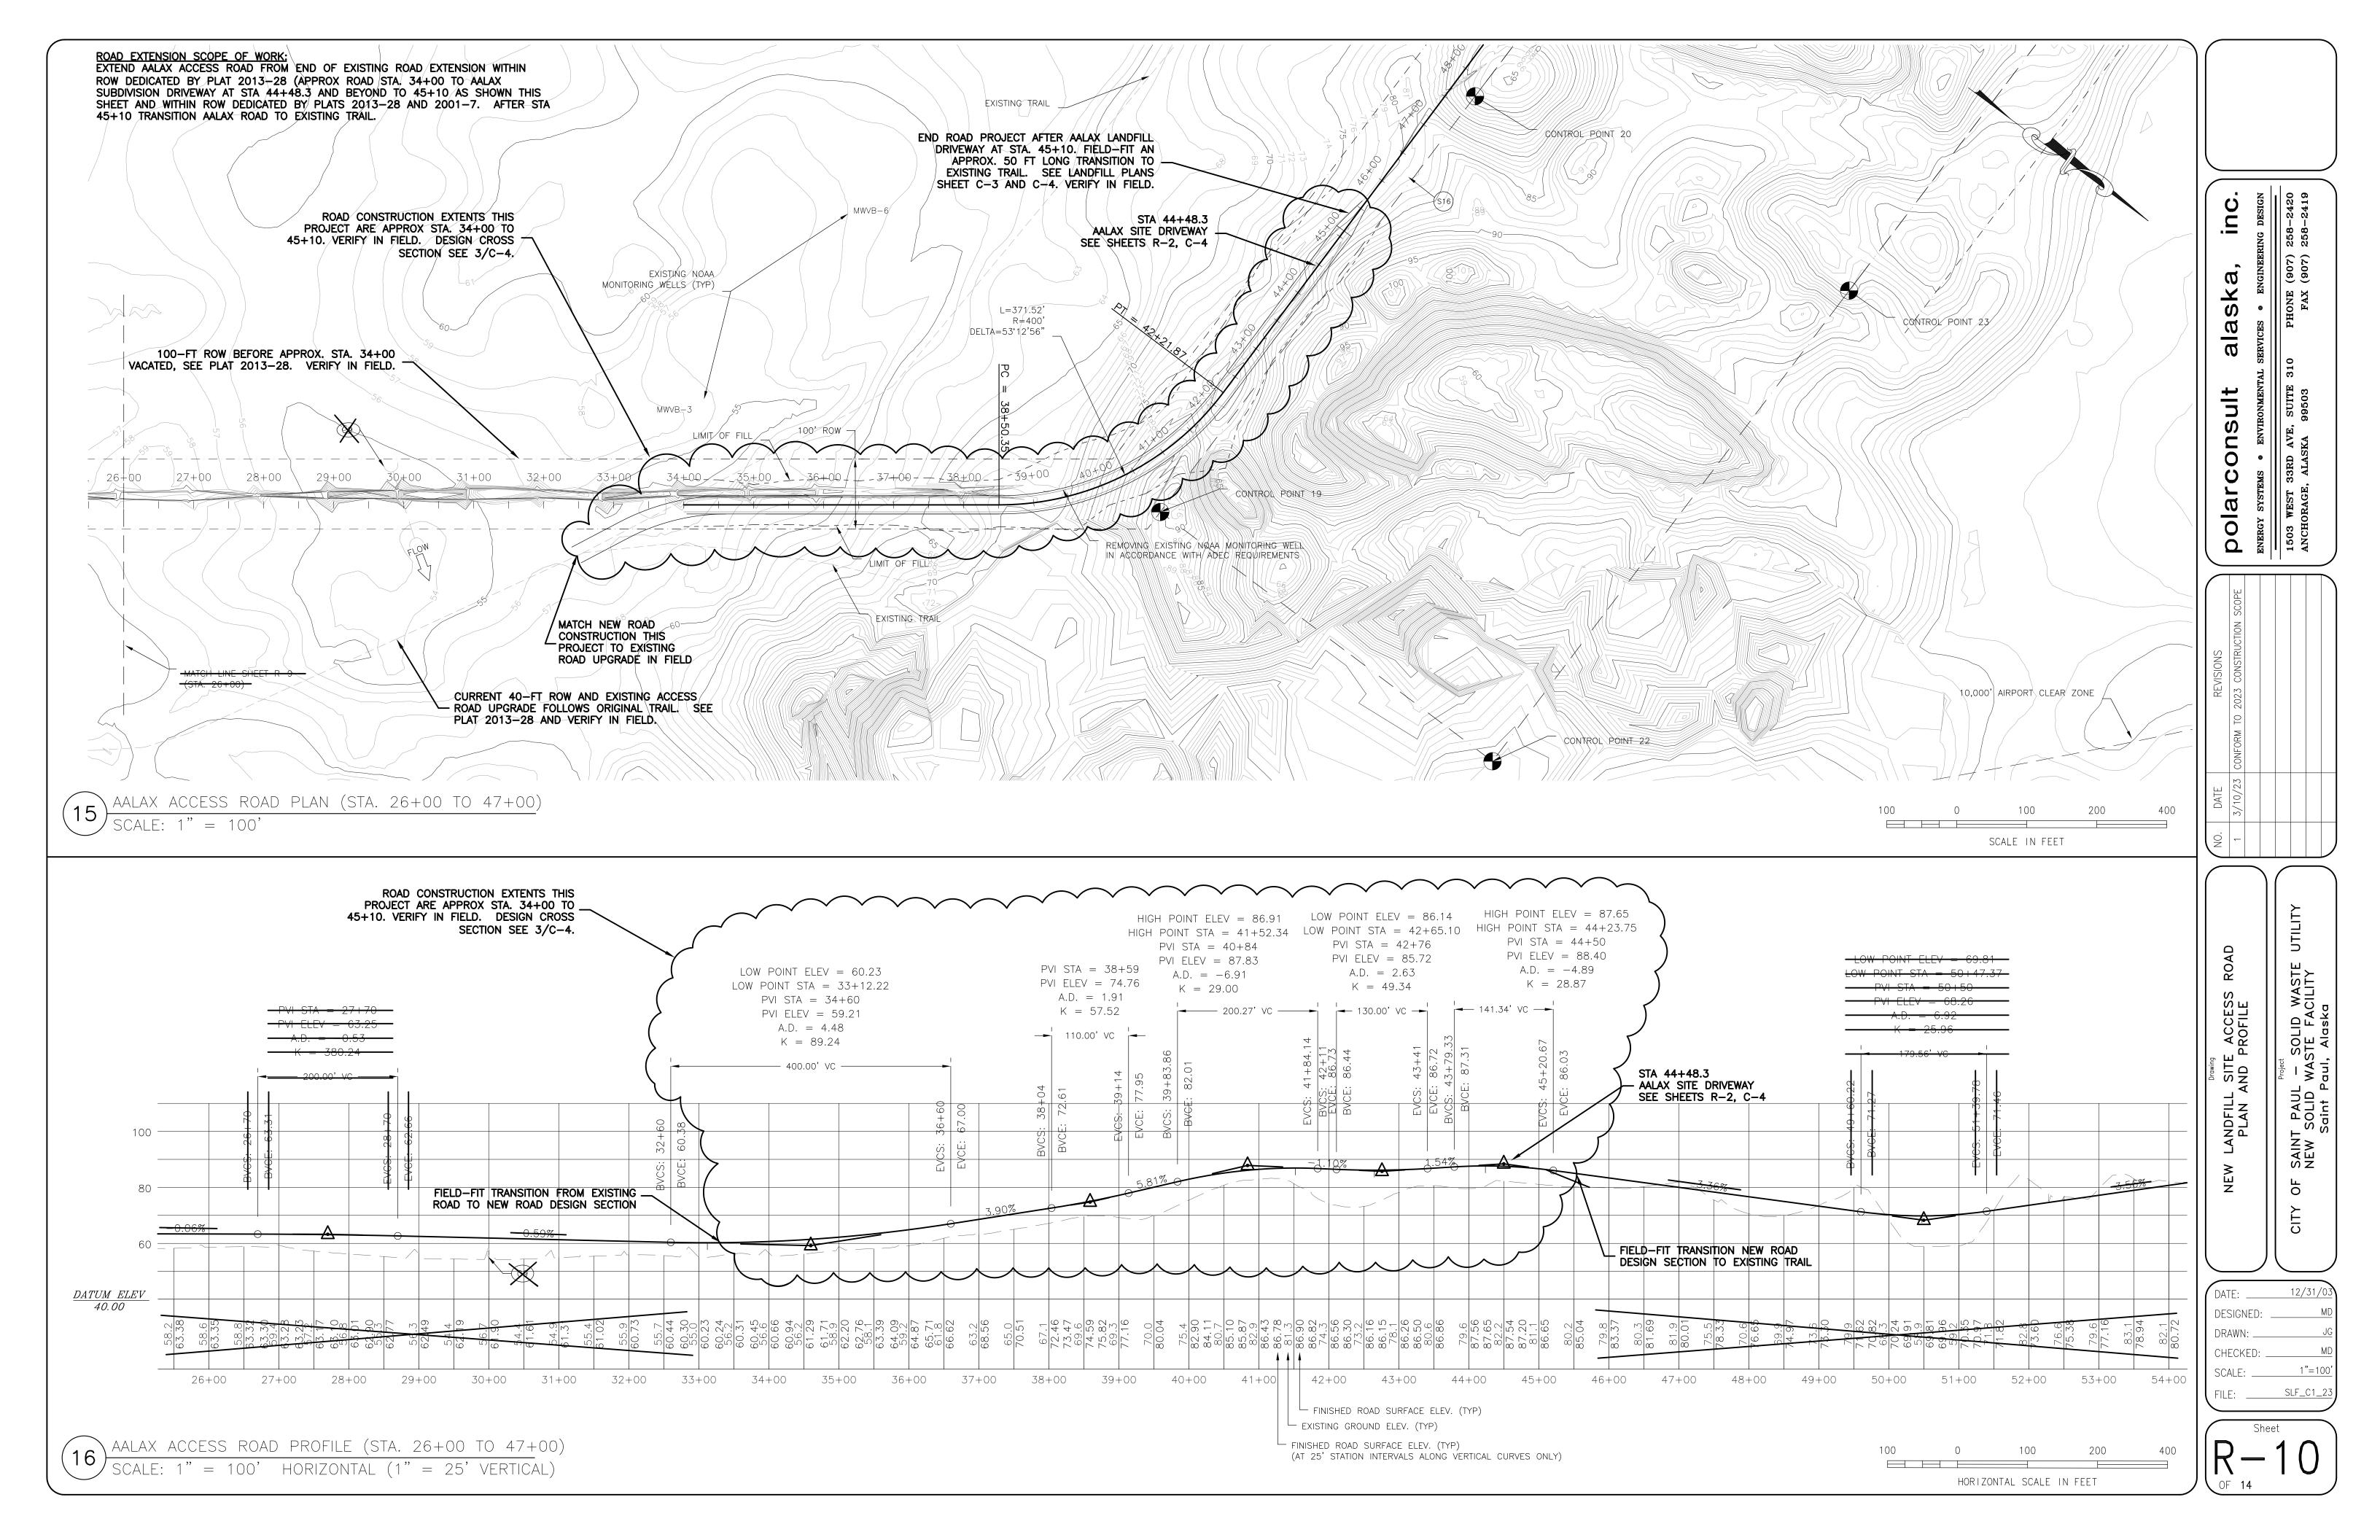
1603 PEST 33RD AVE, SUITE 31
ANCHORAGE, ALASKA 096503


Deceived ROAD CROSS SECTIONS PLAN AND PROFILE

DATE: 12/31/03
DESIGNED: MD
DRAWN: JG
CHECKED: MD
SCALE: 1*=10'(H)
FILE: SLF_C1

P

R-2



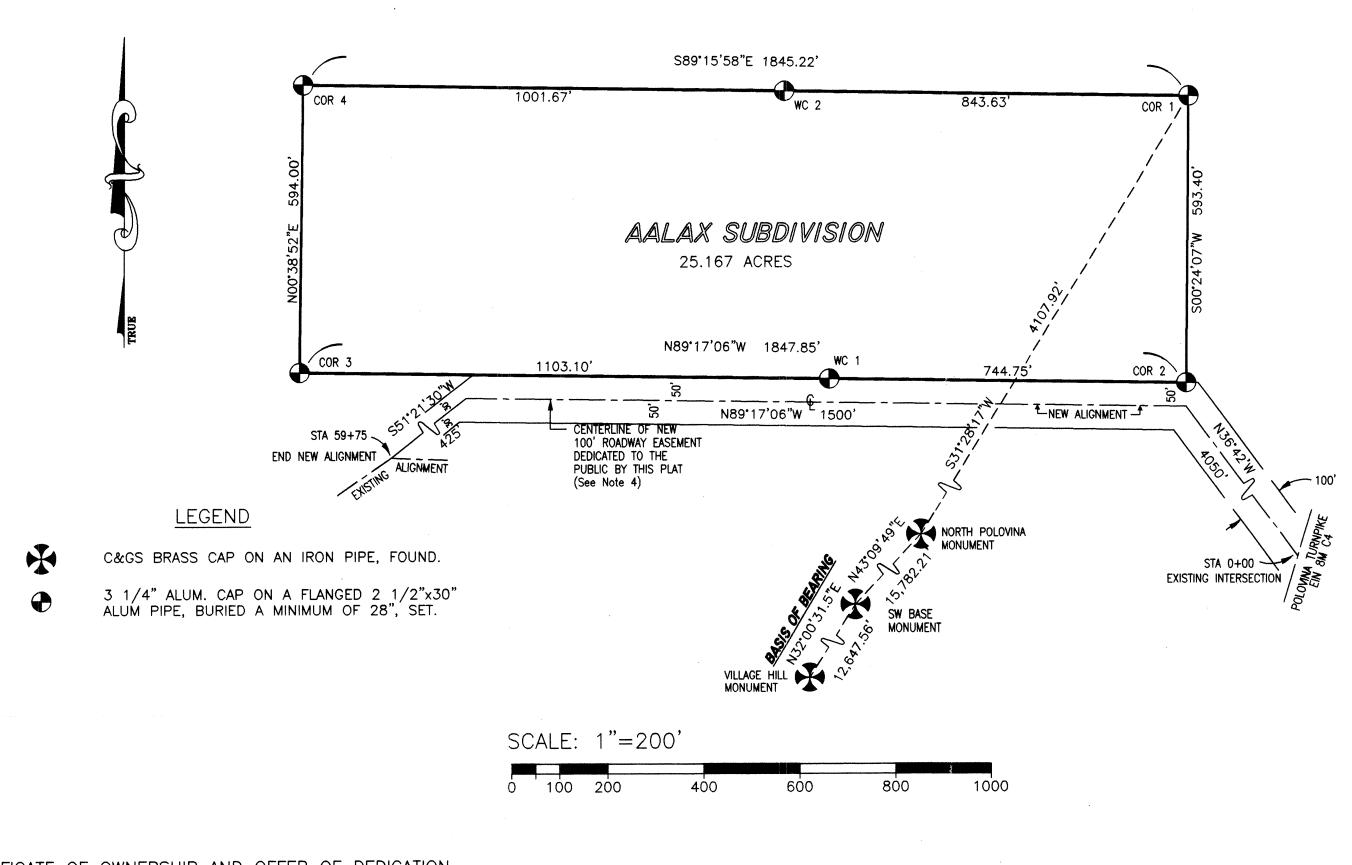

<u>NOTES</u>


- 1. BEARINGS SHOWN ON THIS PLAT ARE TRUE MEAN BEARINGS.
- 2. THE TOTAL AREA OF AALAX SUBDIVISION IS 25.167 ACRES.
- 3. THIS SUBDIVISION LIES OUTSIDE OF ANY TAXING AUTHORITY AT THE TIME
- 4. UPON CONSTRUCTION WITHIN THE NEW ROADWAY ALIGNMENT, THE EXISTING ROADWAY FROM STATION 0+00 TO 59+75 IS TO BE ABANDONED AND RE-SEEDED.
- 5. THE CITY OF ST. PAUL AGREES NOT TO RESTRICT PUBLIC ACCESS ALONG THE ROADWAY EASEMENT BY GATES OR OTHER MEANS, OTHER THAN FOR EMERGENCY PURPOSES OR ROUTINE MAINTENENCE.

CERTIFICATE OF REGISTERED LAND SURVEYOR

I RICHARD C. HEIEREN HEREBY CERTIFY THAT I AM A REGISTERED LAND SURVEYOR IN THE STATE OF ALASKA, THAT THIS PLAT IS A TRUE AND CORRECT REPRESENTATION OF LANDS SURVEYED BY ME OR UNDER MY DIRECT SUPERVISION. THAT THE DISTANCES AND BEARINGS ARE SHOWN CORRECTLY, AND THAT ALL MONUMENTS ARE SET AND NOTED UPON THE PLAT AS PRESENTED.

3/06/01

44735 REGISTRATION NO.

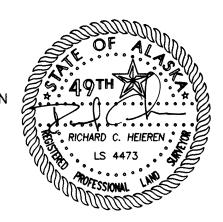



LOCATION: WITHIN SW1/4 SEC. 34 T34S R131W SM AK

OWNER: TANADGUSIX CORPORATION P.O. BOX 88

ST. PAUL ISLAND, AK 99660

RCH SURVEYS 348 DRIVEWAY STREET (907)FAIRBANKS, ALASKA 99701 451-7411


SURVEYOR:

ALEUTIAN RECORDING DISTRICT SHEET 1 OF 1 DESIGNED: KC CHECKED: KC DRAWN: JDS DATE: 3-01-01 SCALE: 1"=200'

Z:\DRAWINGS\2000DWG\STPAUL\AALAX.DWG

CERTIFICATE OF OWNERSHIP AND OFFER OF DEDICATION surface estate of the I HEREBY CERTIFY THAT TANADGUSIX CORPORATION IS THE OWNER OF THE PROPERTY SHOWN AND DESCRIBED HEREON AND DO HEREBY ADOPT THIS PLAT OF SUBDIVISION. WE HEREBY DEDICATE TO THE CITY OF ST PAUL FOR PUBLIC USE THE ACCESS EASEMENT TANADGUSIX CORPORATION SRON Pr aleution Is RECDIST NOTARY'S ACKNOWLEDGMENT COPY Date 6-29 2001 STATE OF ALASKA Firme 9:40 RON P.

ANTHONY PHILEMONOFF ACKNOWLEDGED ME ON 6/14/01 Requested By PNT THAT HE SIGNED THE ABOVE STATEMENTO, THAT THIS PLAT IS HIS ACT. Address N/A NOTARY: PUBLIC MY COMMISSION EXPIRES: US/OULOY NOTARY PUBLIC FOR ALASKA CERTIFICATE OF APPROVAL AND ACCEPTANCE OF DEDICATION THE CITY OF ST PAUL DOES HEREBY APPROVE THIS PLAT FOR RECORDING AND ACCEPTS THE DEDICATION OF THE ROAD EASEMENT FOR PUBLIC USE.

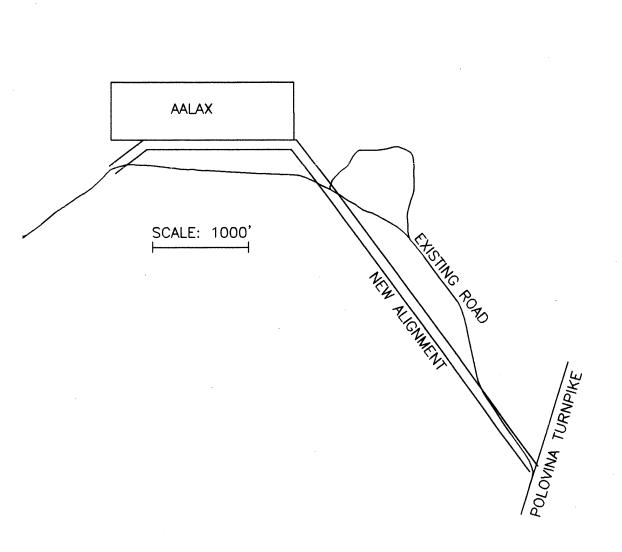

SCALE 1" = 2 MILES

